
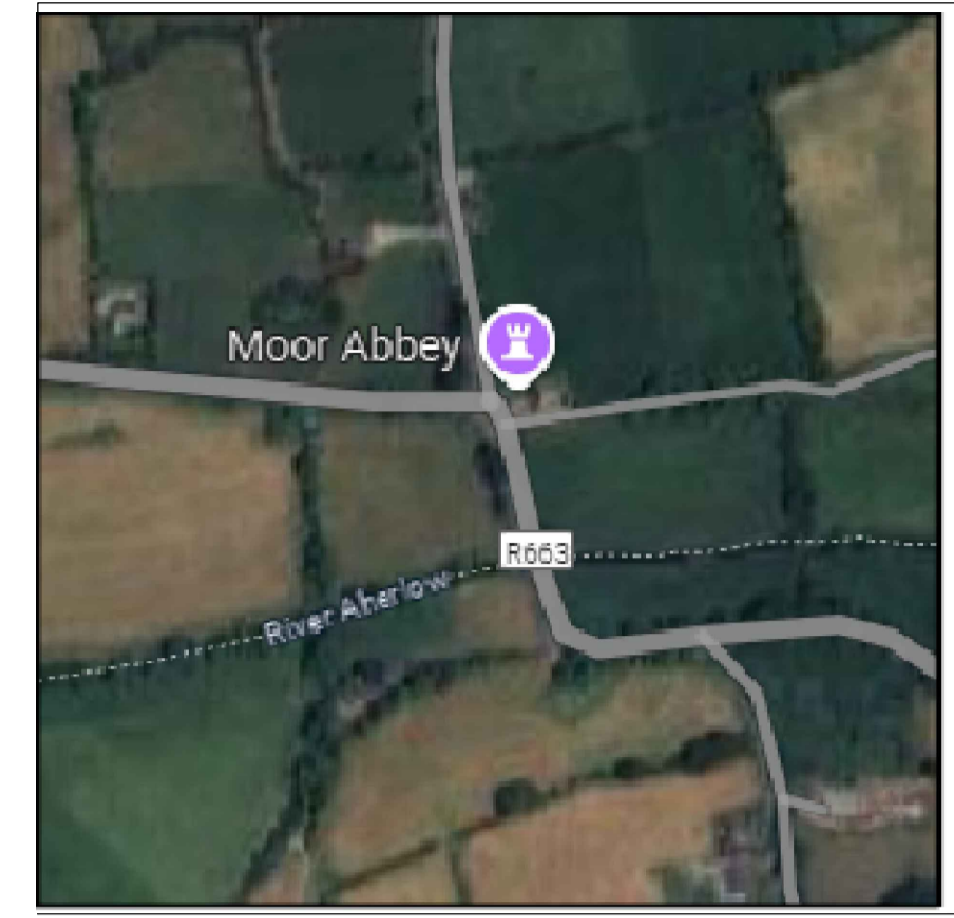


PROPOSED EAST ELEVATION (DOWNSTREAM)  
SCALE 1:100


**LOSS OF POINTING FROM:**

PARAPETS	25%
SPANDRELS	50%
WING WALLS	90%
PIERS (INCLUDING CUTWATERS)	25%
ABUTMENTS	25%
ARCH BARRELS	25%

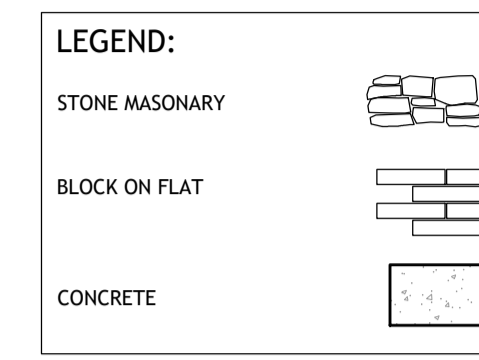

KEY PLAN  
SCALE 1:5000


Ordnance Survey Ireland Licence No EN 0003719  
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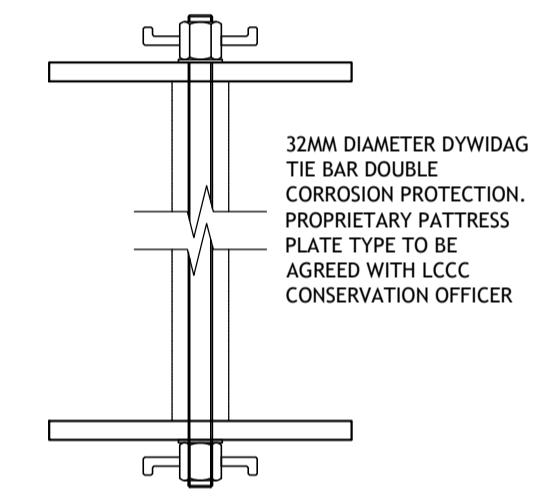
PROPOSED EAST ELEVATION (DOWNSTREAM) - CONTINUED  
SCALE 1:100

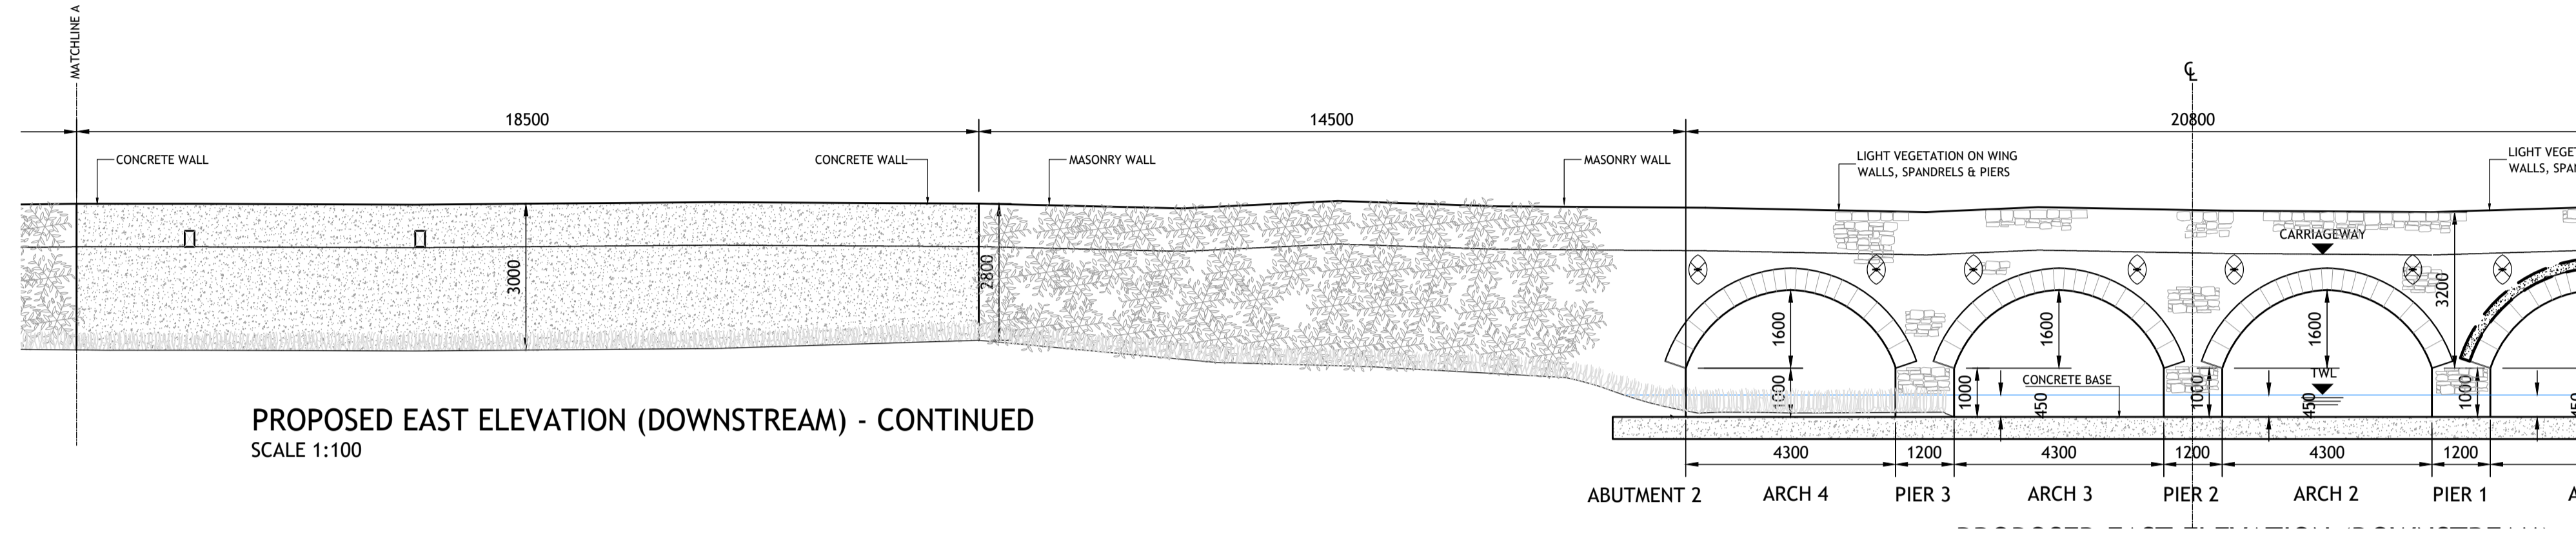**LOCATION**  
GPS COORDINATES: 52.401650, -8.27814

- GENERAL NOTES**
- DO NOT SCALE. ALL DIMENSIONS ON DRAWINGS ARE IN MILLIMETERS UNLESS NOTED OTHERWISE. USE FIGURED DIMENSIONS ONLY.
  - THIS DRAWING IS TO BE READ IN CONJUNCTION WITH ALL OTHER WORKS REQUIREMENTS




PROPOSED EAST ELEVATION (DOWNSTREAM) - CONTINUED  
SCALE 1:100

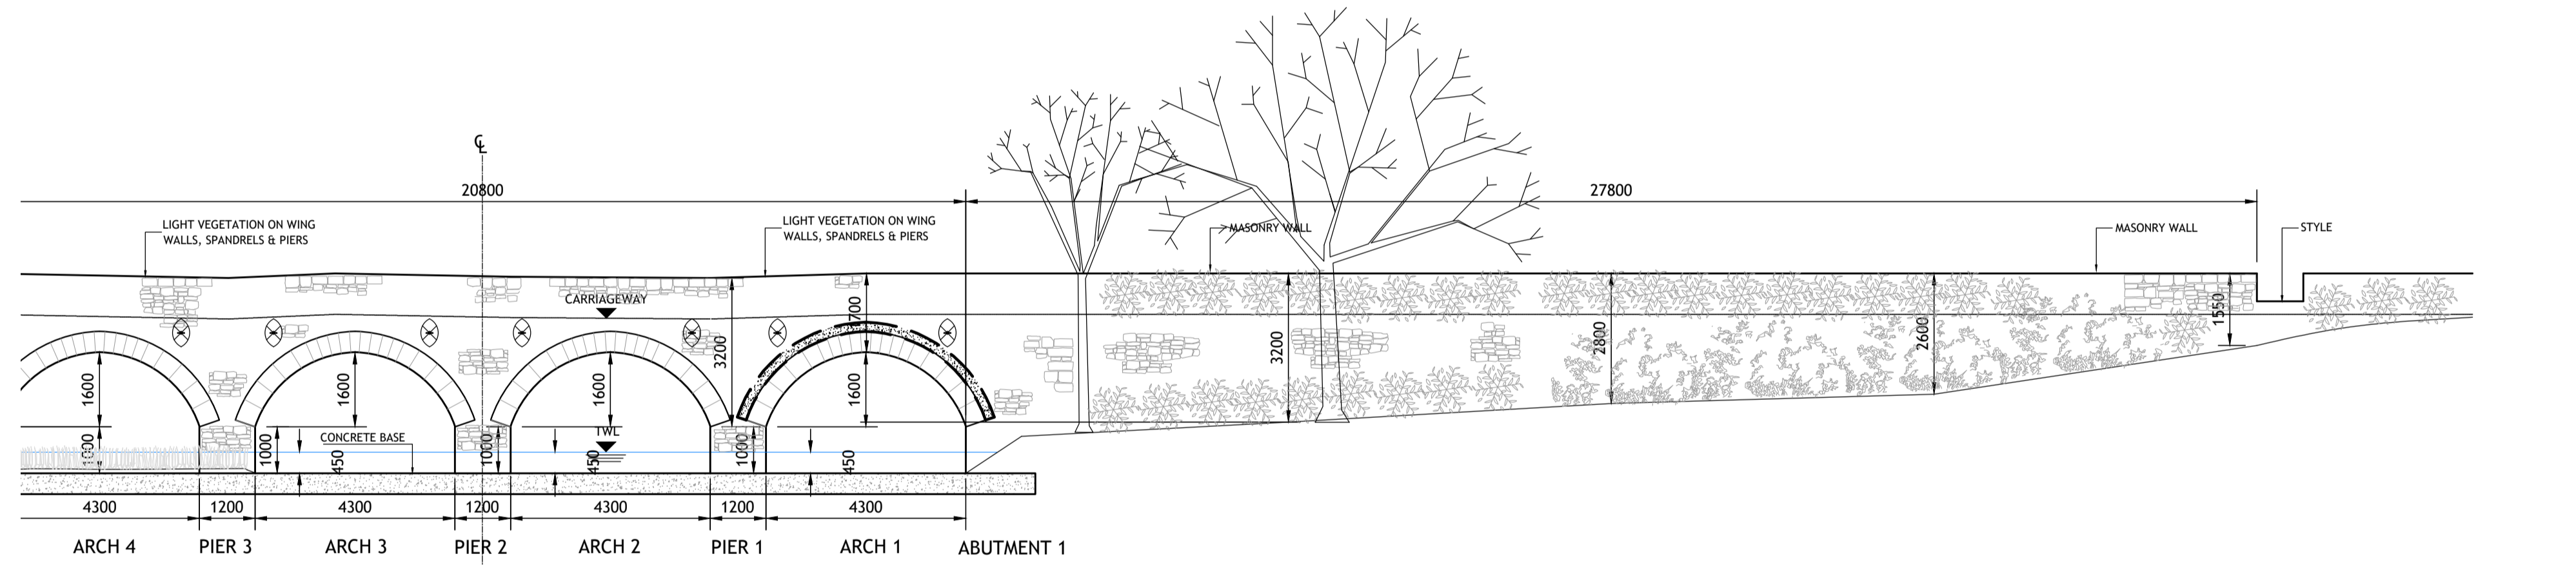


DYWIDAG DETAIL  
SCALE 1:10

- NOTES**
- ALL WORKS TO BE CARRIED OUT IN ACCORDANCE WITH AA SCREENING AND ENVIRONMENTAL REPORTS.
  - ALL QUERIES ON PROPOSED WORKS TO BE DIRECTED TO ENGINEER PRIOR TO UNDERTAKING WORKS.
  - ALL TEMPORARY WORKS ARE THE SOLE RESPONSIBILITY OF THE CONTRACTOR.
  - FINAL SURFACE DRESSING TO NEW ROAD SURFACES WILL BE UNDERTAKEN BY LCCC OUTSIDE THE CONTRACT AT A LATER STAGE.


PROTECTED STRUCTURE:  
NATIONAL BUILT HERITAGE SERVICE Reg. No. 22207301

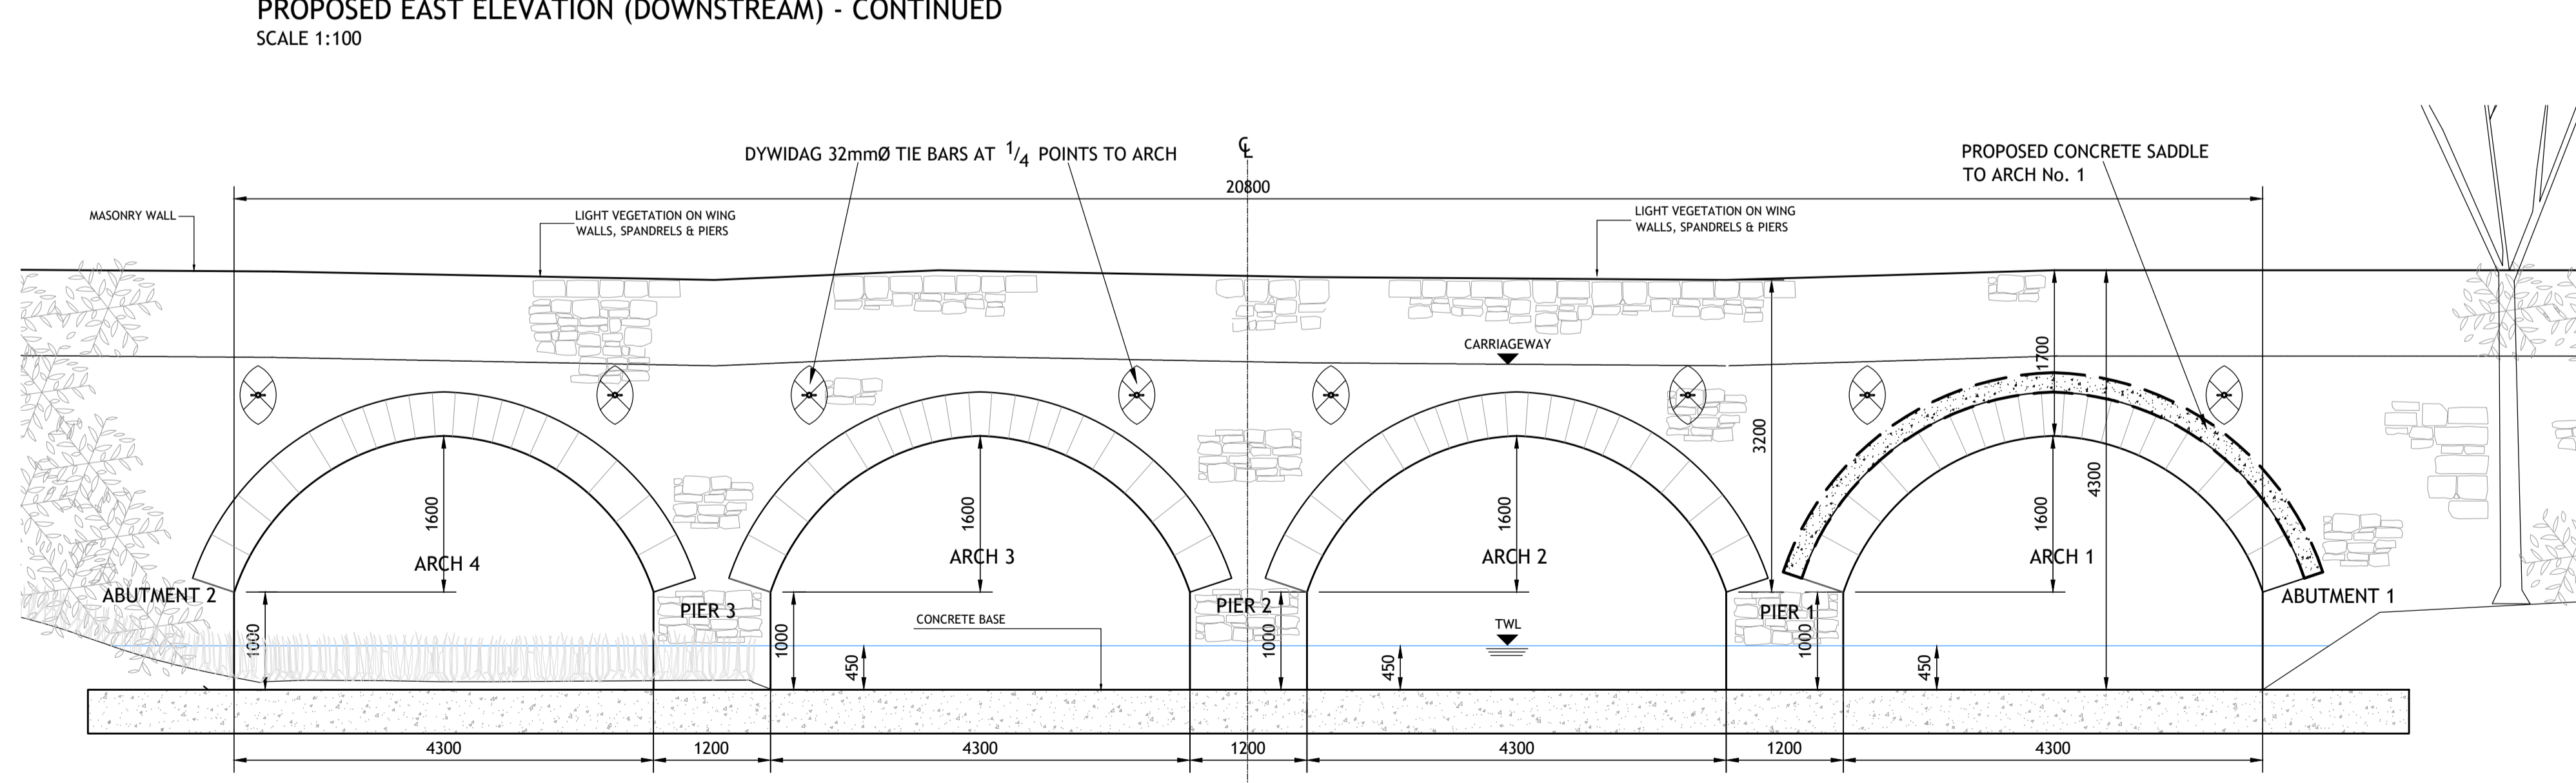

BRIDGE - PROPOSED EAST ELEVATION (DOWNSTREAM)  
SCALE 1:50

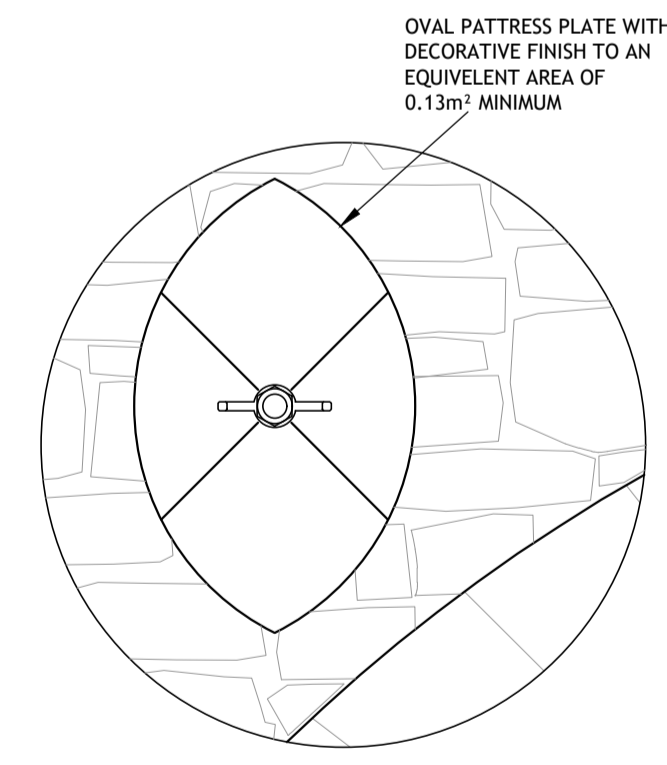

TYPICAL PATRESS PLATE ELEVATION  
SCALE 1:10

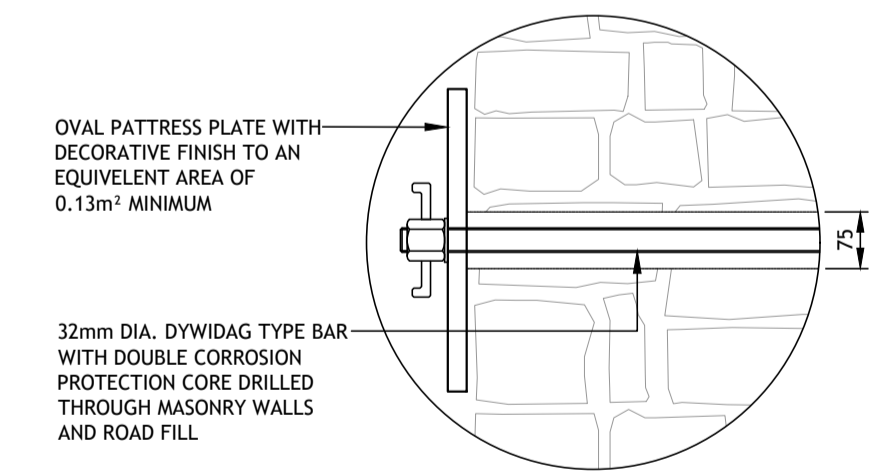

PATRESS PLATE DETAIL SECTION  
SCALE 1:10

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Figured dimension only to be taken from this drawing.  
Consultants to be informed immediately of any discrepancies before work proceeds.



Rev	Amendment	By	Date	Rev	Amendment	By	Date

Client:  
Cahirine O'Connell & Co  
Limerick City & County Council

**PUNCH**  
consulting engineers  
Dublin | Limerick | Cork | Galway | Glasgow

Project:	LCCC 2024 BRIDGE REHABILITATION SCHEME		
Title:	MOOREABBEY - PROPOSED - SH 1 OF 3		
Drawn:	FM	Date drawn:	15.12.2020
Project No:	221254	Technician Check:	F. McInerney
Scale @ A1:	As Shown	Engineering Check:	M. O'Sullivan
Model Ref:	221254-PUNCH-24-XX-M2-CS-0913	Approved:	M. O'Sullivan
Documentation:	221254-PUNCH-24-XX-DR-C-0913	Drawing Status:	S1
Revision No:	P01		