


A0

Do not scale


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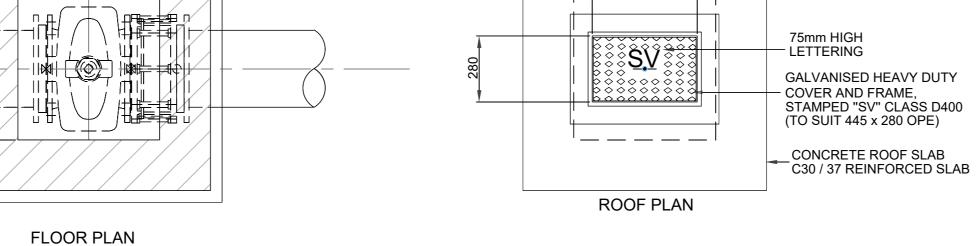
В

С

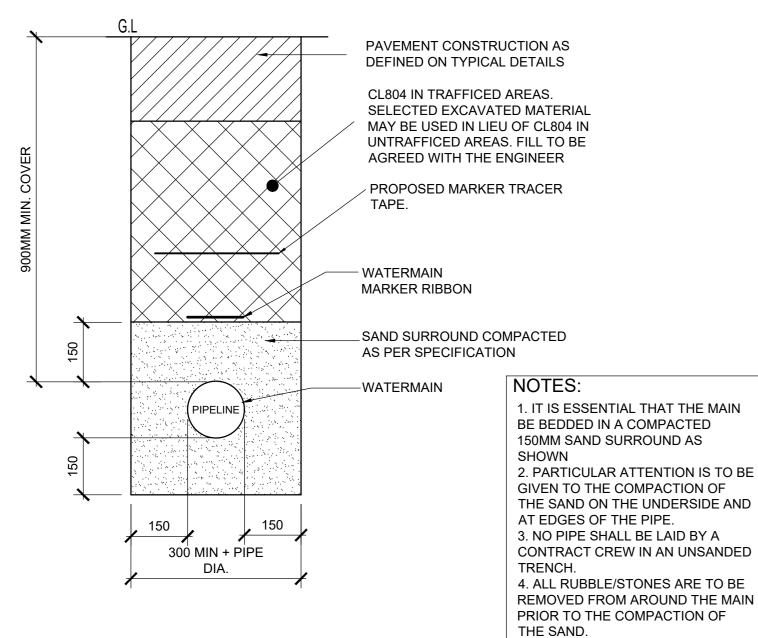


TYPICAL BEDDING DETAIL FOR WATERMAIN SCALE 1:10




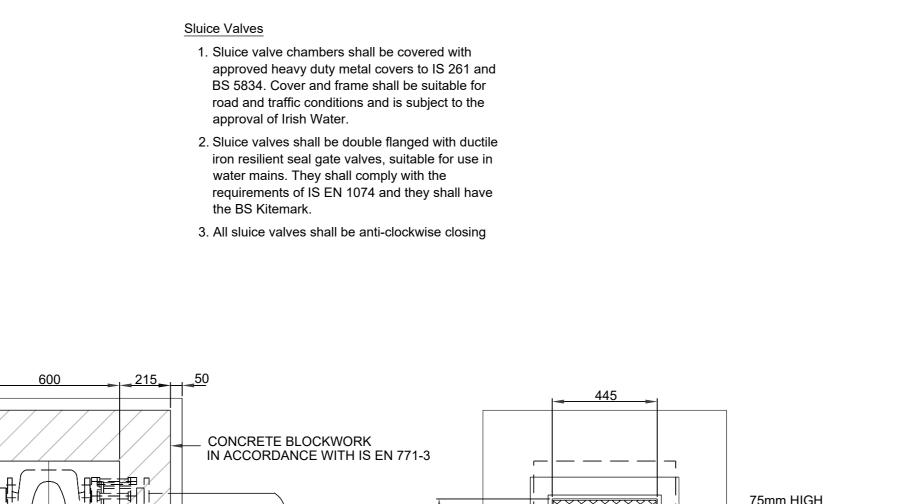



REFER TO IRISH WATER STANDARD DETAILS STD-W-15 FOR DETAILS OF SLUICE VALVE CONNECTION FOR PE PIPEWORK

- Meter Chamber
- 1. Structural design and reinforcement detail to be provided by the developer and submitted to Irish Water for review.
- 2. Concrete for flow meter chamber to be C30/37.
- 3. Meter chamber shall be covered with approved heavy duty metal covers to IS EN 124:1994 rating D400. Cover and frame shall be suitable for road and traffic conditions and is subject to the approval of Irish Water.
- 4. All chambers to be checked for uplift by the developer based on ground conditions within the site. Should anti floating measures be required they shall be subject to approval from Irish Water.
- 5. Pipework to be downsized to accommodate the required range of the flow meter, straight pipe lengths upstream and downstream of the meter to be provided. If the meter is not capable of accurate night flow measurements a by-pass flow meter shall be provided with appropriate valves, fittings and pipework.

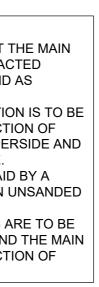

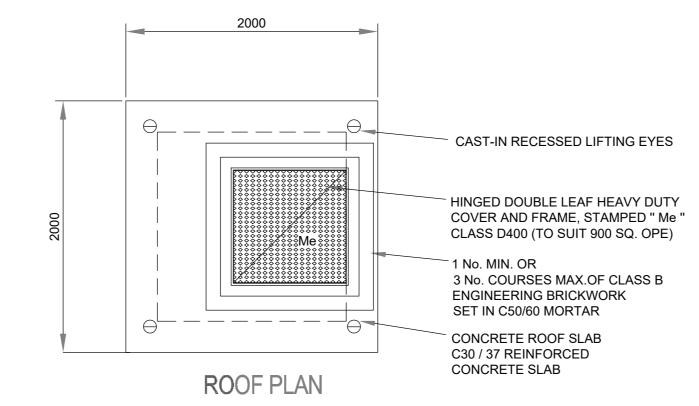

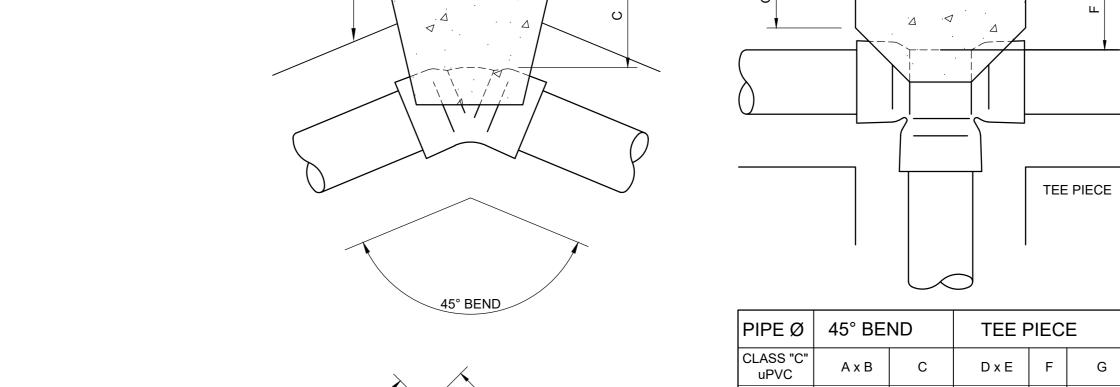

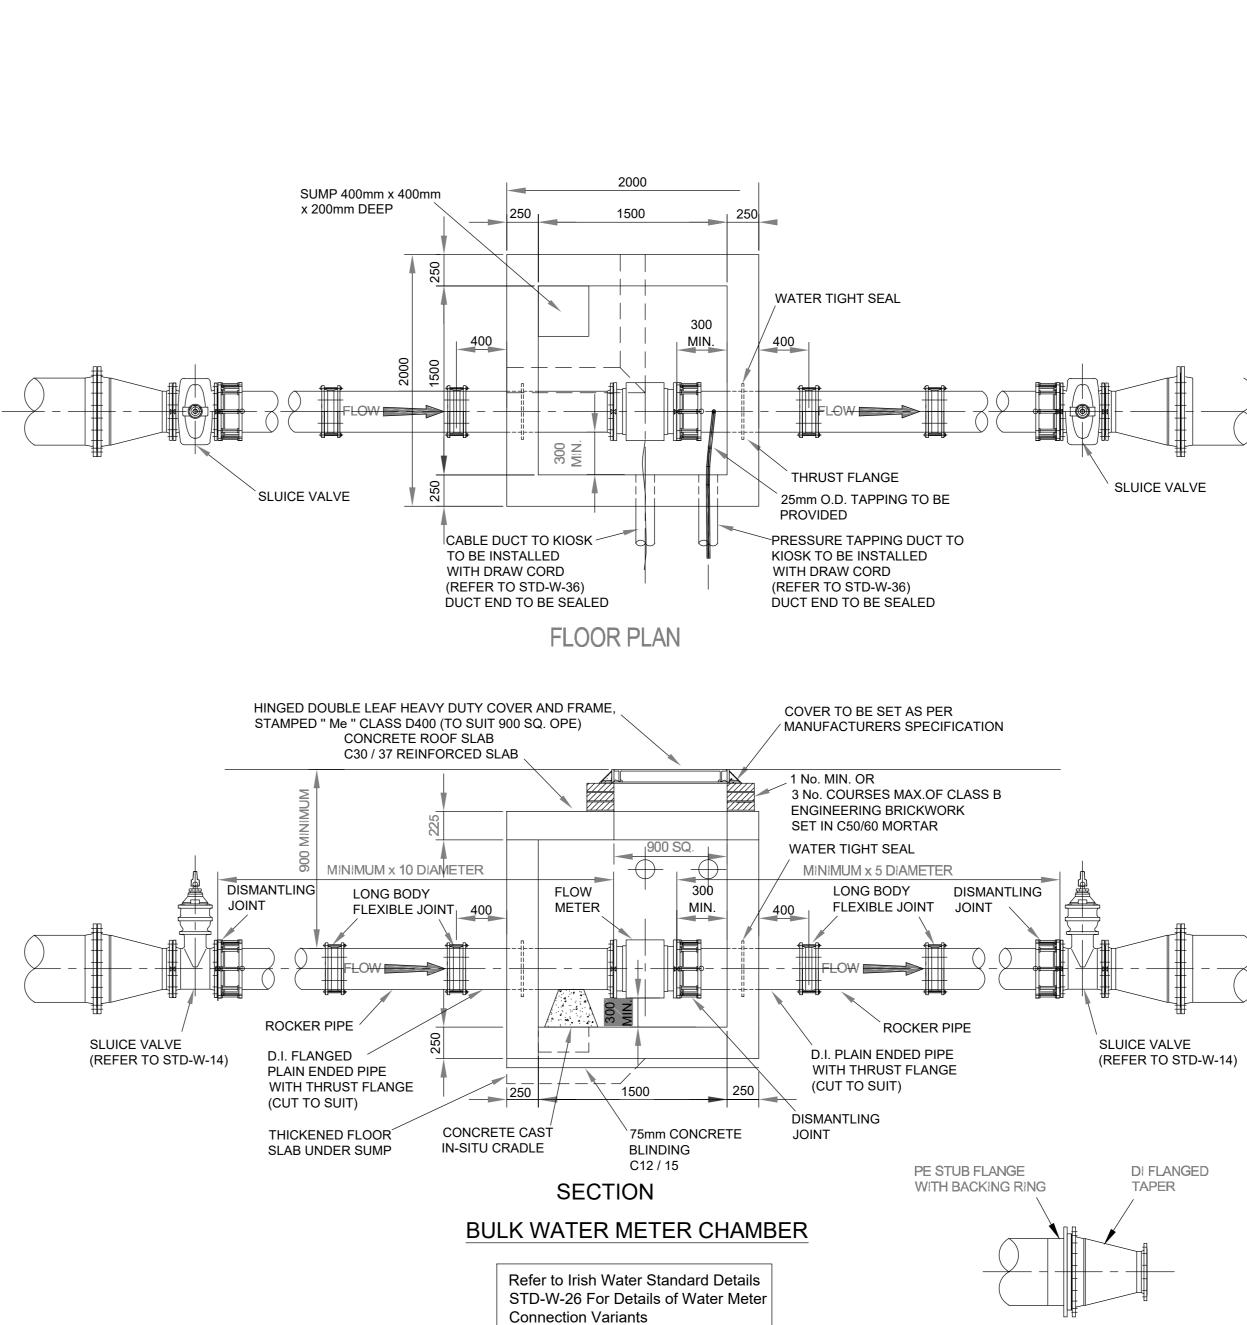

THRUST BLOCK DETAILS


90° BEND

200

250

NOTE

TRENCH WALL

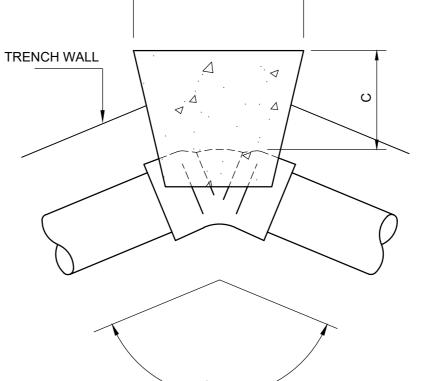

AxB

## DхE TEE PIECE TEE PIECE

100 330x350 50 MIN. 390x350 200 50 MIN.

150 510x450 50 MIN. 660x450 225 50 MIN.

REQUIRE ADDITION OF THRUST BLOCKS

600x650 50 MIN. 790x650 300 50 MIN.

600x650 50 MIN. 790x650 300 50 MIN.

Т	U

## TRENCH WALL

90° BEND			
К			
200			
225			
300			
300			
	К 200 225 300		

THRUST BLOCKS ARE DESIGNED FOR AN AVERAGE GROUND BEARING PRESSURE OF 100kN/m<sup>2</sup> (TYPICAL FOR SOFT CLAY). FOR OTHER GROUND CONDITIONS ACTUAL DIMENSIONS MAY BE ALTERED ON INSTRUCTIONS FROM THE ENGINEER. THRUST BLOCKS IN THE MAIN SHOULD NOT BE REQUIRED AS JOINTS ARE TO BE FULLY RESTRAINED. DETAILS INCLUDED HERE IN THE EVENT IRISH WATER TIE IN DETAILS

## Notes:

- . This Drawing shall be Read in Conjunction with all Other Relevant Specifications & Drawings including Civil Site Drawings.
- . All Dimensions in mm unless otherwise noted.
- . Refer to MUN-ARUP-ZZ-ZZ-DR-C-0040 for the Proposed Potable Watermain Layout.
- 4. All Water Infrastructure to be Designed and Constructed in Accordance with the Irish Water Code of Practice and Standard Details.

P01 20/01/21 ROD RM KG Issued for Planning Rev Date By Chkd Appd

ARUP

Arup, Hartstonge House, Upper Hartstonge Street, Limerick Tel +353 (061) 212100 www.arup.com

Limerick City & County Council

Project Title

Client

Mungret Residential Development, Mungret, Limerick

Drawing Title

Proposed Potable Water Details

Scale at A0 As Shown Role Civil Infrastructure Suitability S2 - Suitable for Information

Arup Job No 261585-00

MUN-ARUP-ZZ-ZZ-DR-C-0102

Rev P01